

GENERAL NOTES

ASSOCIATION.

1. ALL WORKMANSHIP WILL BE TO THE STANDARDS OF LANDSCAPE ONTARIO.

2. ALL PLANT MATERIAL TO BE NO.1 GRADE NURSERY GROWN IN ACCORDANCE WITH THE CANADIAN STANDARDS FOR NURSERY STOCK, 9TH EDITION, 2017, BY THE CANADIAN NURSERY TRADES

3. BACKFILL WILL CONSIST OF SOIL NATIVE TO THE SITE OR GENERAL SOIL TYPE/CLASS NATIVE TO THE SITE. TOPSOIL TO BE TESTED FOR NUTRIENT VALUE, AND AMENDED FOR OPTIMAL GROWTH AS PER THE RECOMMENDATIONS OF THE SOIL TEST.

4. CONTRACTOR SHALL MAINTAIN ALL LANDSCAPE AREAS UNTIL OWNER'S ACCEPTANCE OF PROJECT.

5. CONTRACTOR TO LOCATE ALL UNDERGROUND UTILITIES.6. PLANTING MAY BE ADJUSTED TO SUIT LOCATIONS OF SITE UTILITY STRUCTURES/SERVICES.

7. ALL MATERIALS MUST BE APPROVED BY LANDSCAPE ARCHITECT PRIOR TO INSTALLATION.

8. SPREAD MULCH TO A MINIMUM OF 100mm COMPACTED DEPTH ON ALL TREE PITS AND PLANTING BEDS.

9. CHECK AND VERIFY ALL DIMENSIONS AND QUANTITIES PRIOR TO COMMENCEMENT OF WORK. ANY DISCREPANCIES ARE TO BE REPORTED IN WRITING TO THE LANDSCAPE ARCHITECT. QUANTITIES NOTED WITHIN THE PLAN SUPERCEDE THOSE IN THE PLANT LIST. ANY SUBSTITUTIONS SHALL BE APPROVED BY THE LANDSCAPE ARCHITECT.

10. SOD AS MARKED WITH NURSERY SOD ON A MINIMUM OF 100mm OF CLEAN TOPSOIL. FINE GRADE AND SOD ALL BOULEVARD AREAS TO MUNICIPAL SPECIFICATIONS AND REPAIR DAMAGE TO ADJACENT PROPERTIES, AS REQUIRED.

11. FINAL INSPECTION AND ACCEPTANCE OF PLANTING WORK SHALL COINCIDE WITH THE FINAL INSPECTION AND ACCEPTANCE OF ALL WORK INCLUDED IN THE CONTRACT.

12. ALL SEEDED SLOPES 3:1 AND GREATER TO RECEIVE EROSION CONTROL MATTING. PIN SOD ON ALL SLOPES OF 3:1 OR GREATER.

13. SUBMIT A WRITTEN GUARANTEE TO THE EFFECT THAT ALL PLANTS ACCEPTED DURING THE PERIOD OF JANUARY 1st TO JULY 15th SHALL BE GUARANTEED UNTIL JULY 15th THE FOLLOWING YEAR. PLANTS ACCEPTED DURING THE PERIOD OF JULY 15th TO DECEMBER 31st SHALL BE GUARANTEED FOR ONE YEAR FROM THE DATE OF ACCEPTANCE. THE GUARANTEE PERIODS LISTED ABOVE SHALL APPLY TO ALL "NURSERY GROWN" PLANTS.

14. AT THE TIME OF FINAL INSPECTION ALL PLANTS SHALL BE IN A HEALTHY, VIGOUROUS GROWING CONDITION, PLANTED IN FULL ACCORDANCE WITH DRAWINGS AND CONDITIONS.

15. SITE PLAN INFORMATION AS PER SALTER PILON ARCHITECTURE.

16. ENGINEERING AS PER WSP, AND IS PROVIDED FOR INFORMATION ONLY.

17. SITE LIGHTING BY OTHERS





REVISIONS no. date description

EXISTING TREES TO REMAIN

SIZE

60 mm

50 mm

60 mm

60 mm

60 mm

60 mm

175 cm

60 mm

3 gal.

1 gal.

COND.

W.B.

W.B.

W.B.

W.B.

W.B.

W.B.

W.B.

W.B.

Pot

Pot

Pot

Pot

PROPERTY LINE

PROPOSED TREES

COMMONNAME

Sugar Maple

Serviceberry

Katsura Tree

Tulip Tree

Burr Oak

Bayberry

Maidenhair Tree

New Jersey Tea

Fragrant Sumac

Goldflame Spirea

Narrow-leaf Coneflower

Stella D'Oro Daylilly

Little Blue Stem

Dw arf Golden Japanese Yew 3 gal

Black Hills White Spruce

1. Jul.18.24 Issued for Approval
2. Aug.09.24 60% Contract Documents
3. Aug.26.24 Issued for Approval

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Salter Pilon Architecture 4182 Sixth Line Oakville

Landscape Plan




PROJECT NO.: 2023-97	DRAWN BY: JC
SCALE: 1:200	DESIGNED BY: JC
SHEET:	APPROVED BY: AWH

PLOT DATE: Feb/14/2025

2

.AUTO_OP\Drawings\xxxx\xx

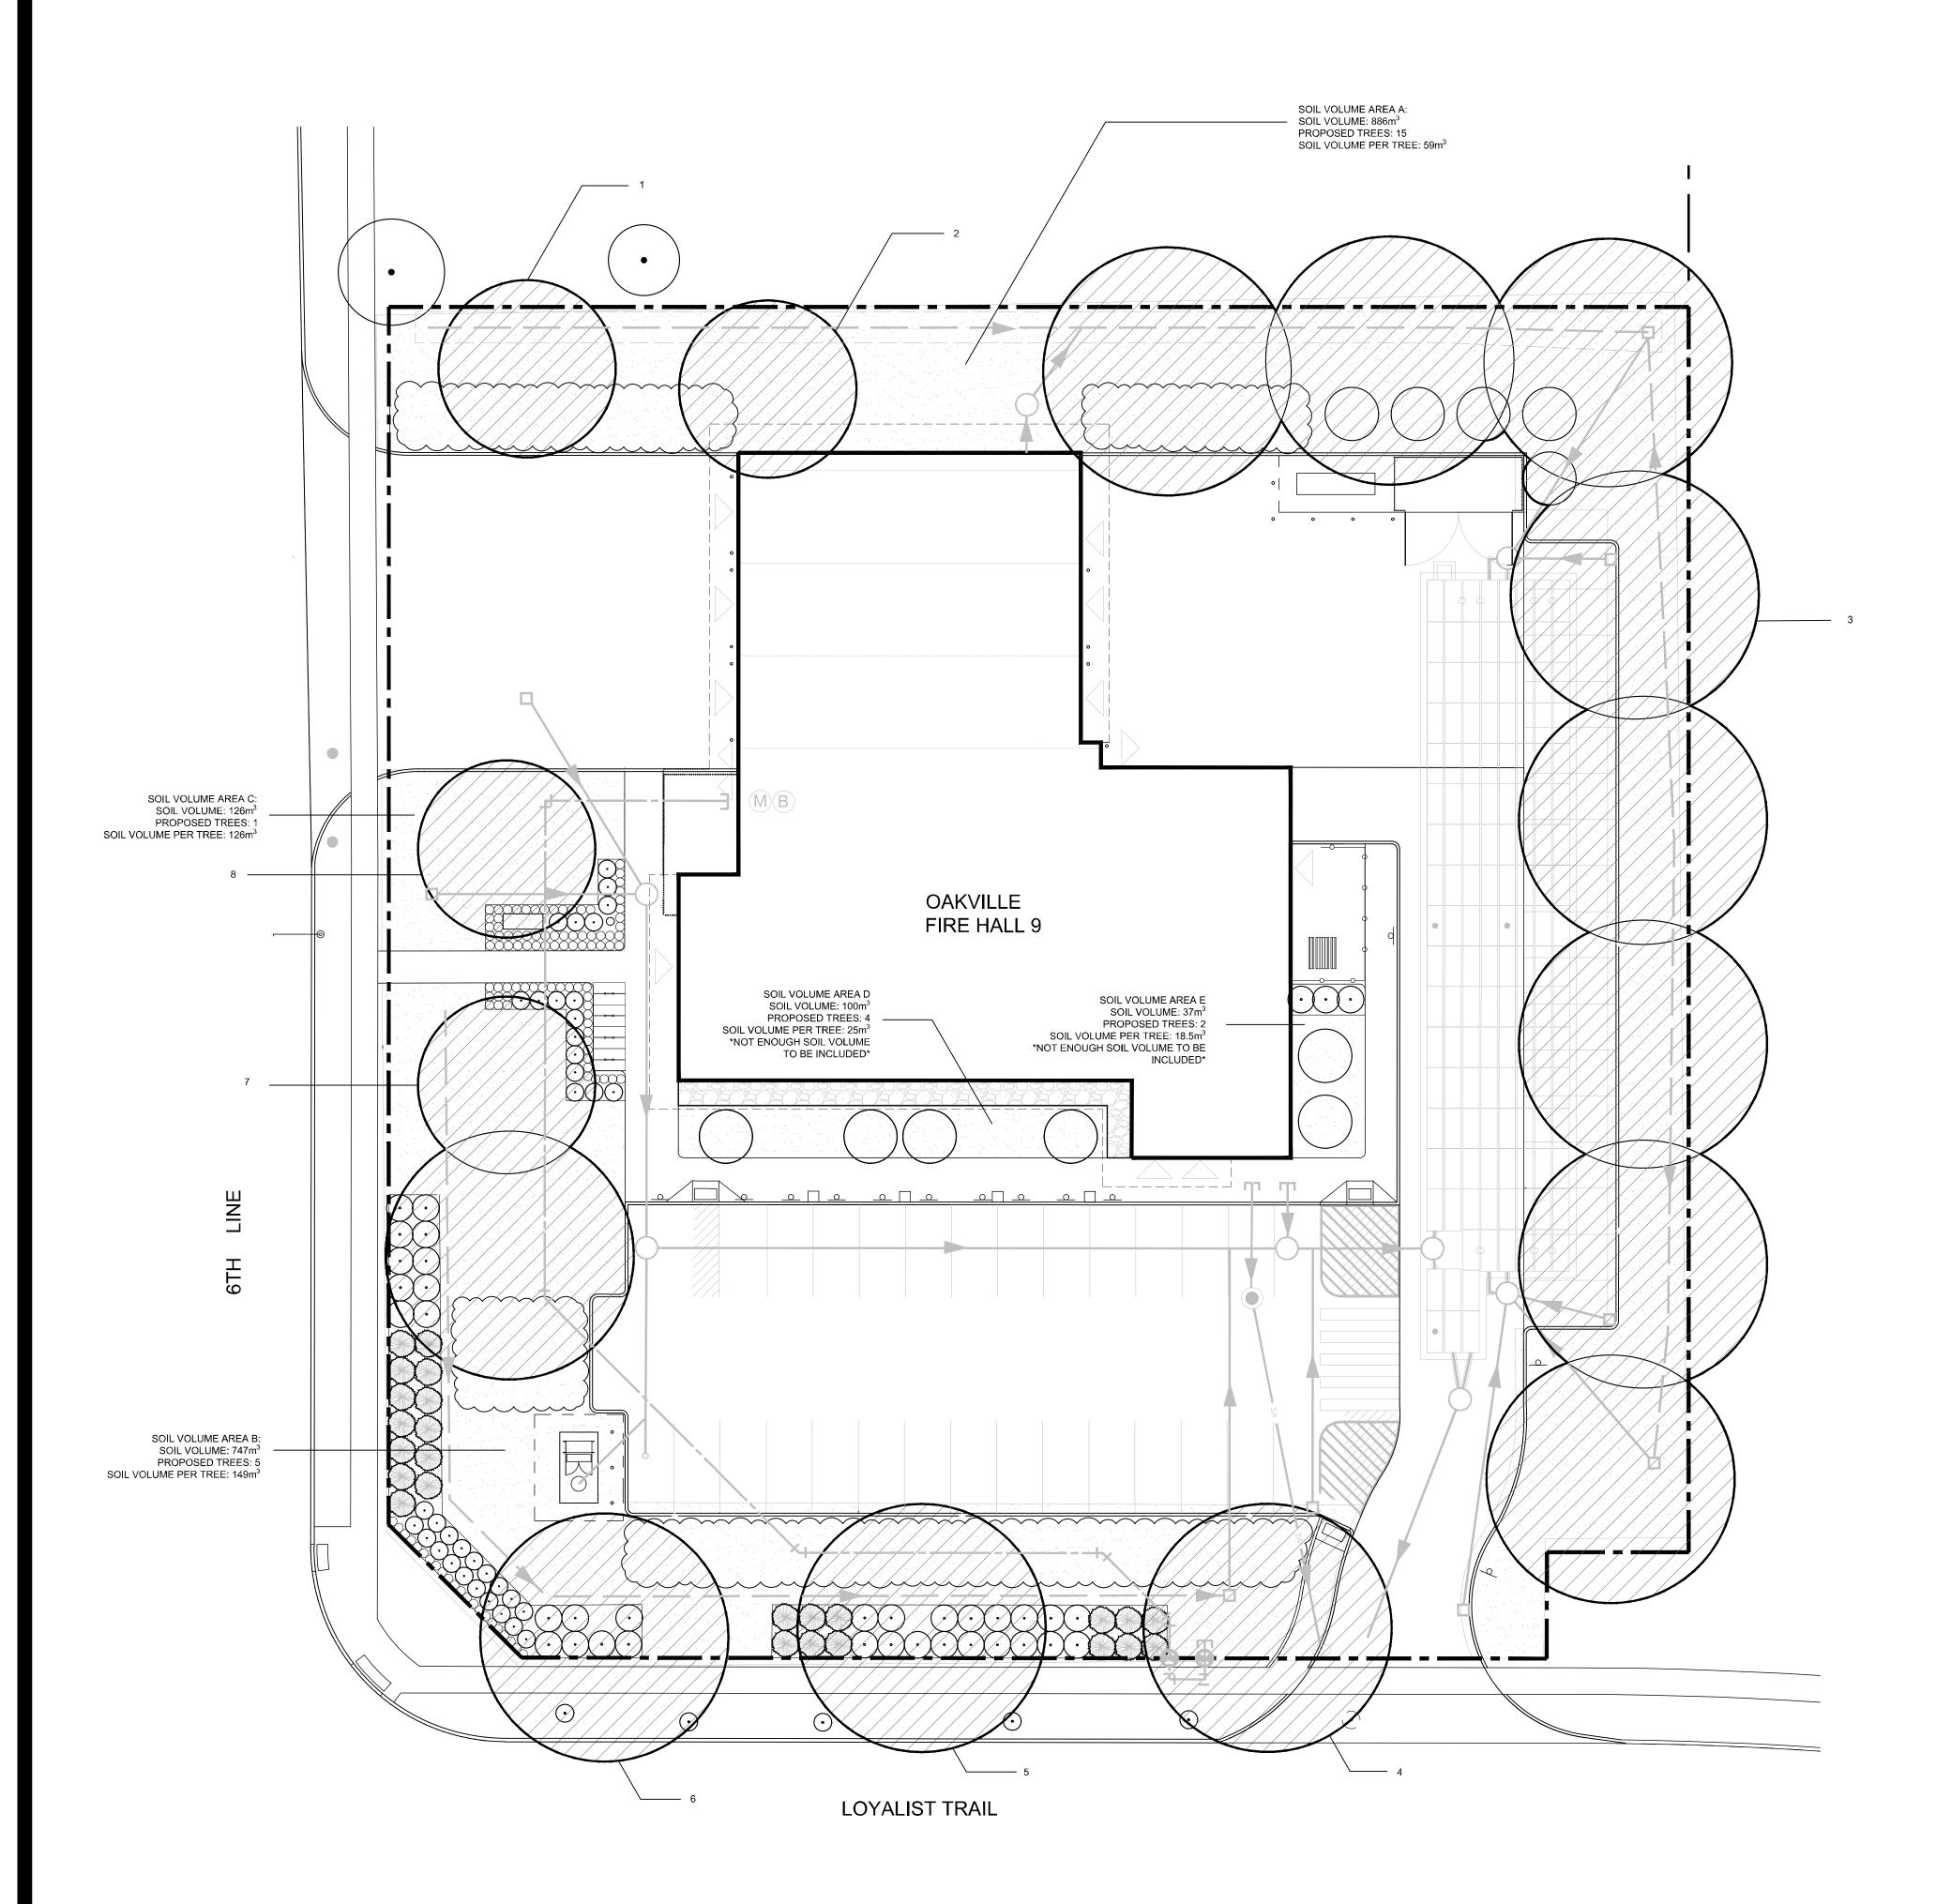


CANOPY CALCULATION CHART

Canopy Key	Tree Quantity	Stature	Soil Volue Area		Canopy Area (m2) **Does not include canopy overla
•	-	P	roposed Car	nopy on Site	
1	1	М	А	59	78.5
2	1	М	A	59	78.5
3	13	L - 7 S - 5	А	59	1215
4	1	L	В	149	154
5	1	L	В	149	154
6	1	L	В	149	154
7	2	L -1 M - 1	В	149	223
8	1	М	С	126	78.5
			Propos	ed Canopy Subtotal:	2135.5
 Canopy Cove	rage Summ	 ary			
Proposed Ca		-	2135.5		
Existing Can	opy On Site	(m2)	0		
Existing Can	opy Overlap	ping Site (m2)	0		
Total Site Are	ea (m2)		5540		
Site Canopy	Cover %		39%		
Canopy Cove	er Target %		25%		
Parking Area	Summary				
Total Parking	Spaces Pro	pposed:	46		
Total # of Tre	es within 5n	n of Parking:	13		

LEGEND

	CANOPY COVERAGE AREA			
	TREE CANOPY AREA NOT COUNTED			
	TREE SOIL VOLUME AREA			

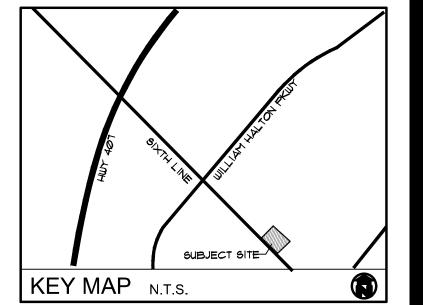

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Salter Pilon Architecture 4182 Sixth Line

Canopy Cover Plan

Oakville




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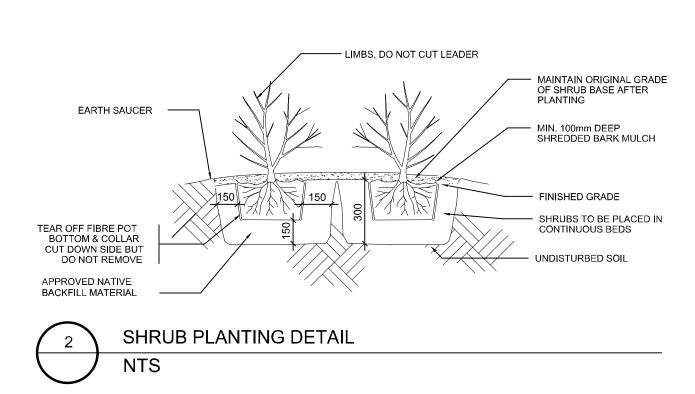
DECIDUOUS TREE PLANTING DETAIL


BIKE RACK BY MAGLIN (OR APPROVED EQUAL) T 1-800-716-5506 F 1-877-260-9393 WWW.MAGLIN.COM SALES@MAGLIN.COM


SPECIFICATIONS: MODEL: MBR-0500-00003 POWDER COAT COLOUR: GUNMETAL, FROM FINE TEXTURED COLLECTION (MATTE FINISH) OPTIONS: SURFACE MOUNT INSTALL AS PER MANUFACTURERS SPECIFICATIONS






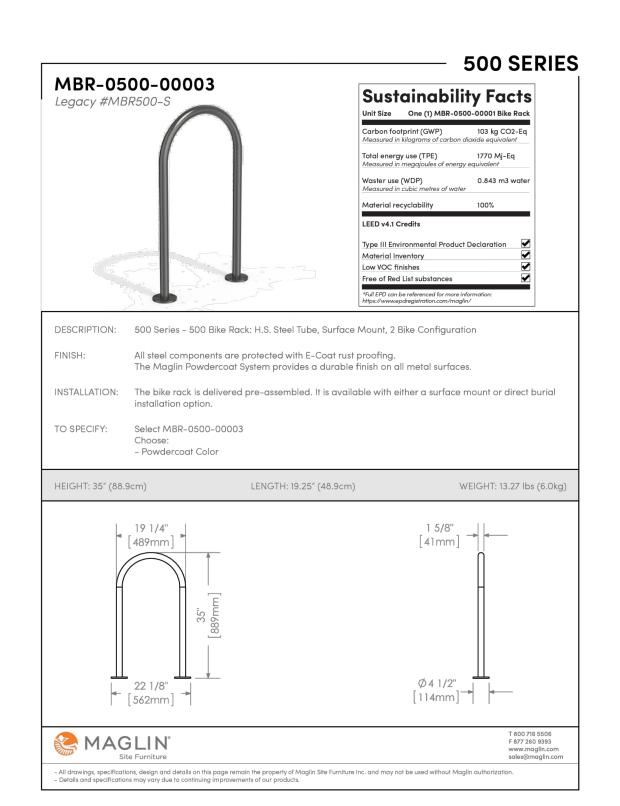

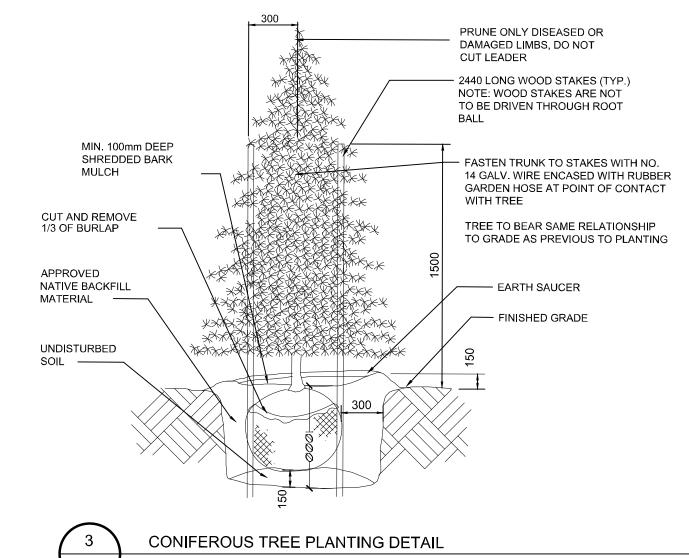

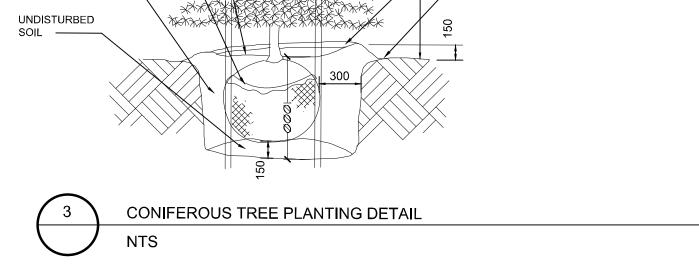

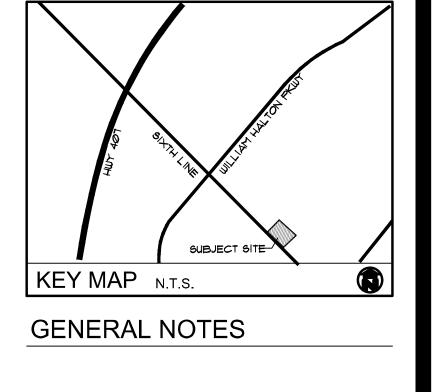



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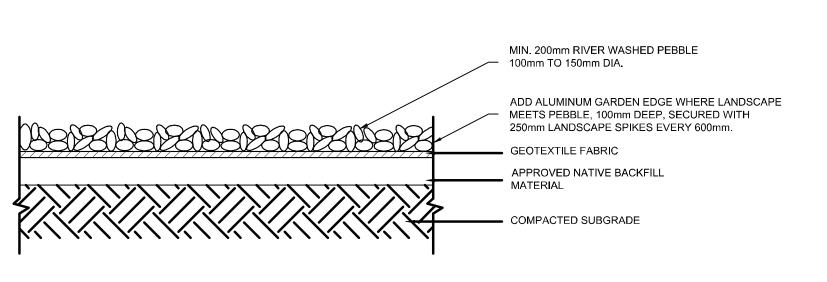
Salter Pilon Architecture 4182 Sixth Line

Oakville

Details



PROJECT NO.: 2023-97 DRAWN BY: JC SCALE: DESIGNED BY: JC SHEET: APPROVED BY: AWH PLOT DATE: Feb/14/2025





RIVER PEBBLE MULCH DETAIL

NTS